


	<u>А</u>	16/05/24 30/07/24	TOWN PLANNING APPLICATION SUBMISSION RFI RESPONSE	DT EL	DRAWING GROUND FLOOR PLAN
	REV. NO.	DATE	AMENDENTS / ISSUE	DRAWN	


CITY OF MARIBYRNONG 03/09/2024 URBAN PLANNING

SCALE		DATE	
1:100 @ A1; 1:2	200 @ A3	JUL 2024	
DRAWN	CHECKED	JOB NO.	
DT	TL	23054	
PROJECT STATUS		DRAWING NO.	REV. NO.
T O W N P L A N N	I N G	TP-05	В

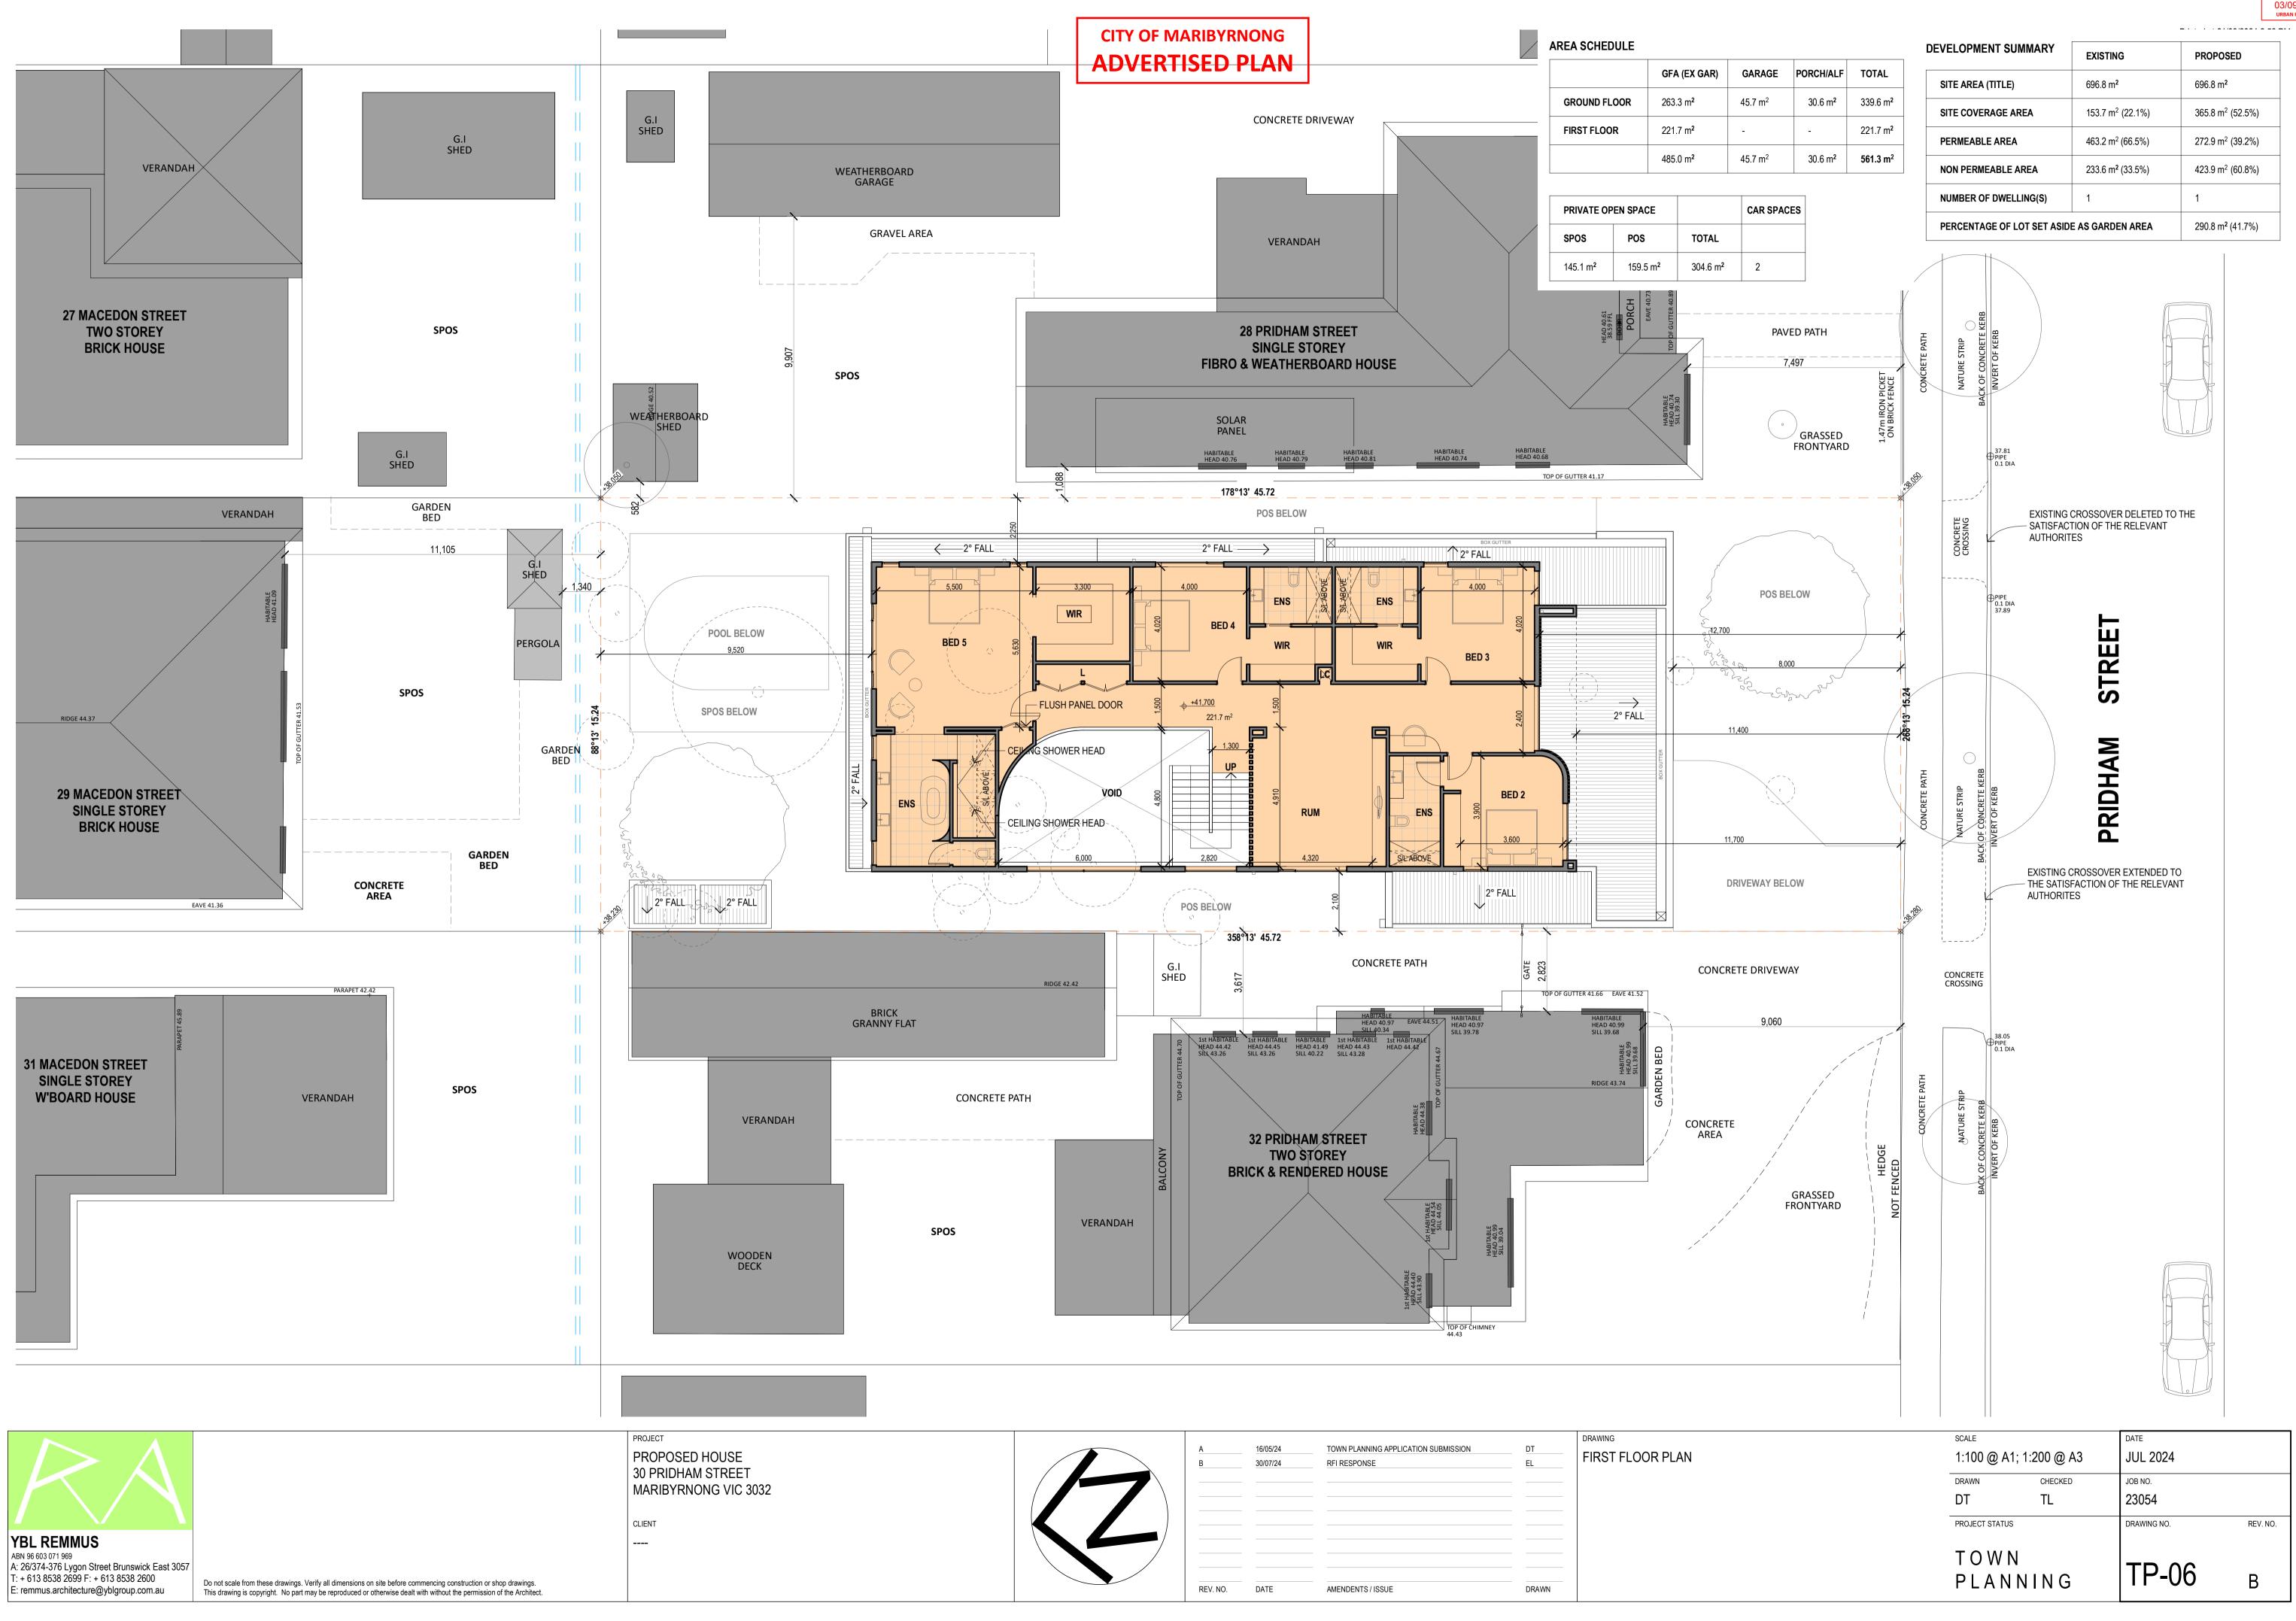


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REV. NO.	DATE	AMENDENTS / ISSUE	DRAWN	
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	A	16/05/24 30/07/24	TOWN PLANNING APPLICATION SUBMISSION RFI RESPONSE	DT	DRAWING ROOF PLAN
	REV. NO.	DATE	AMENDENTS / ISSUE	DRAWN	

CITY OF MARIBYRNONG RECEIVED 03/09/2024 URBAN PLANNING

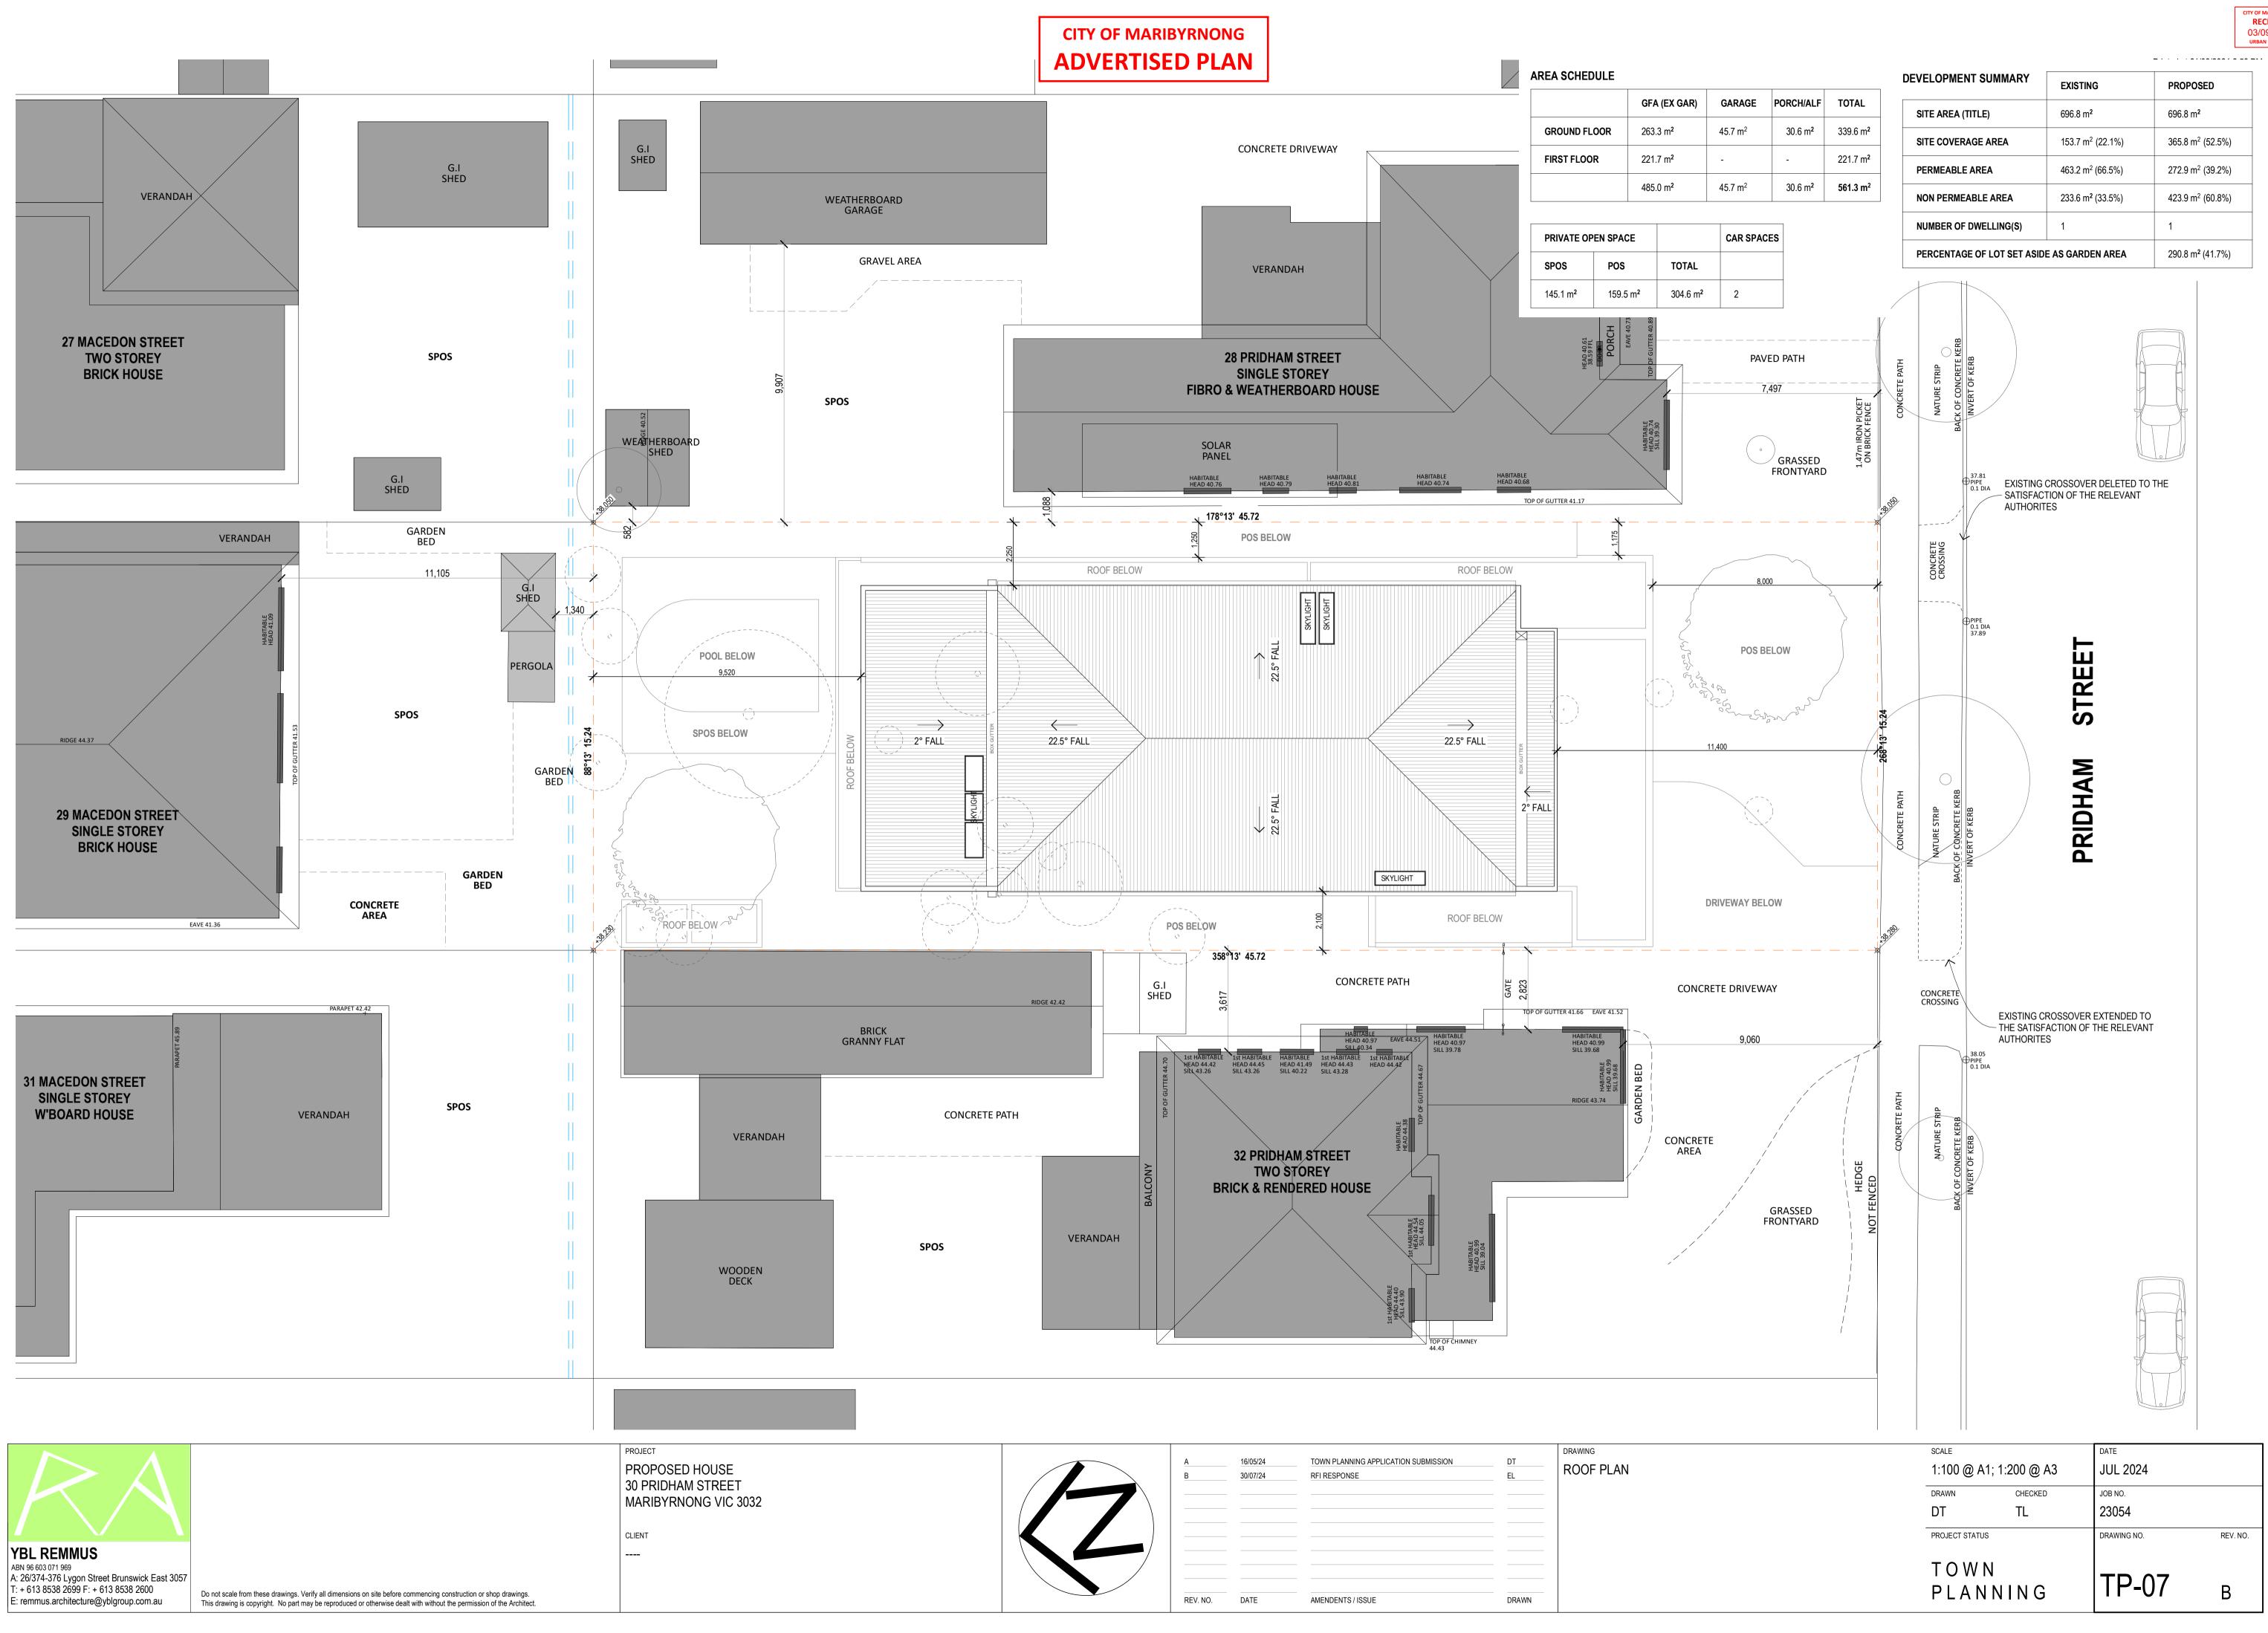

	A B	16/05/24 30/07/24	TOWN PLANNING APPLICATION SUBMISSION RFI RESPONSE	DT EL	DRAWING GARDEN AREA PLAN
	REV. NO.	DATE	AMENDENTS / ISSUE	DRAWN	

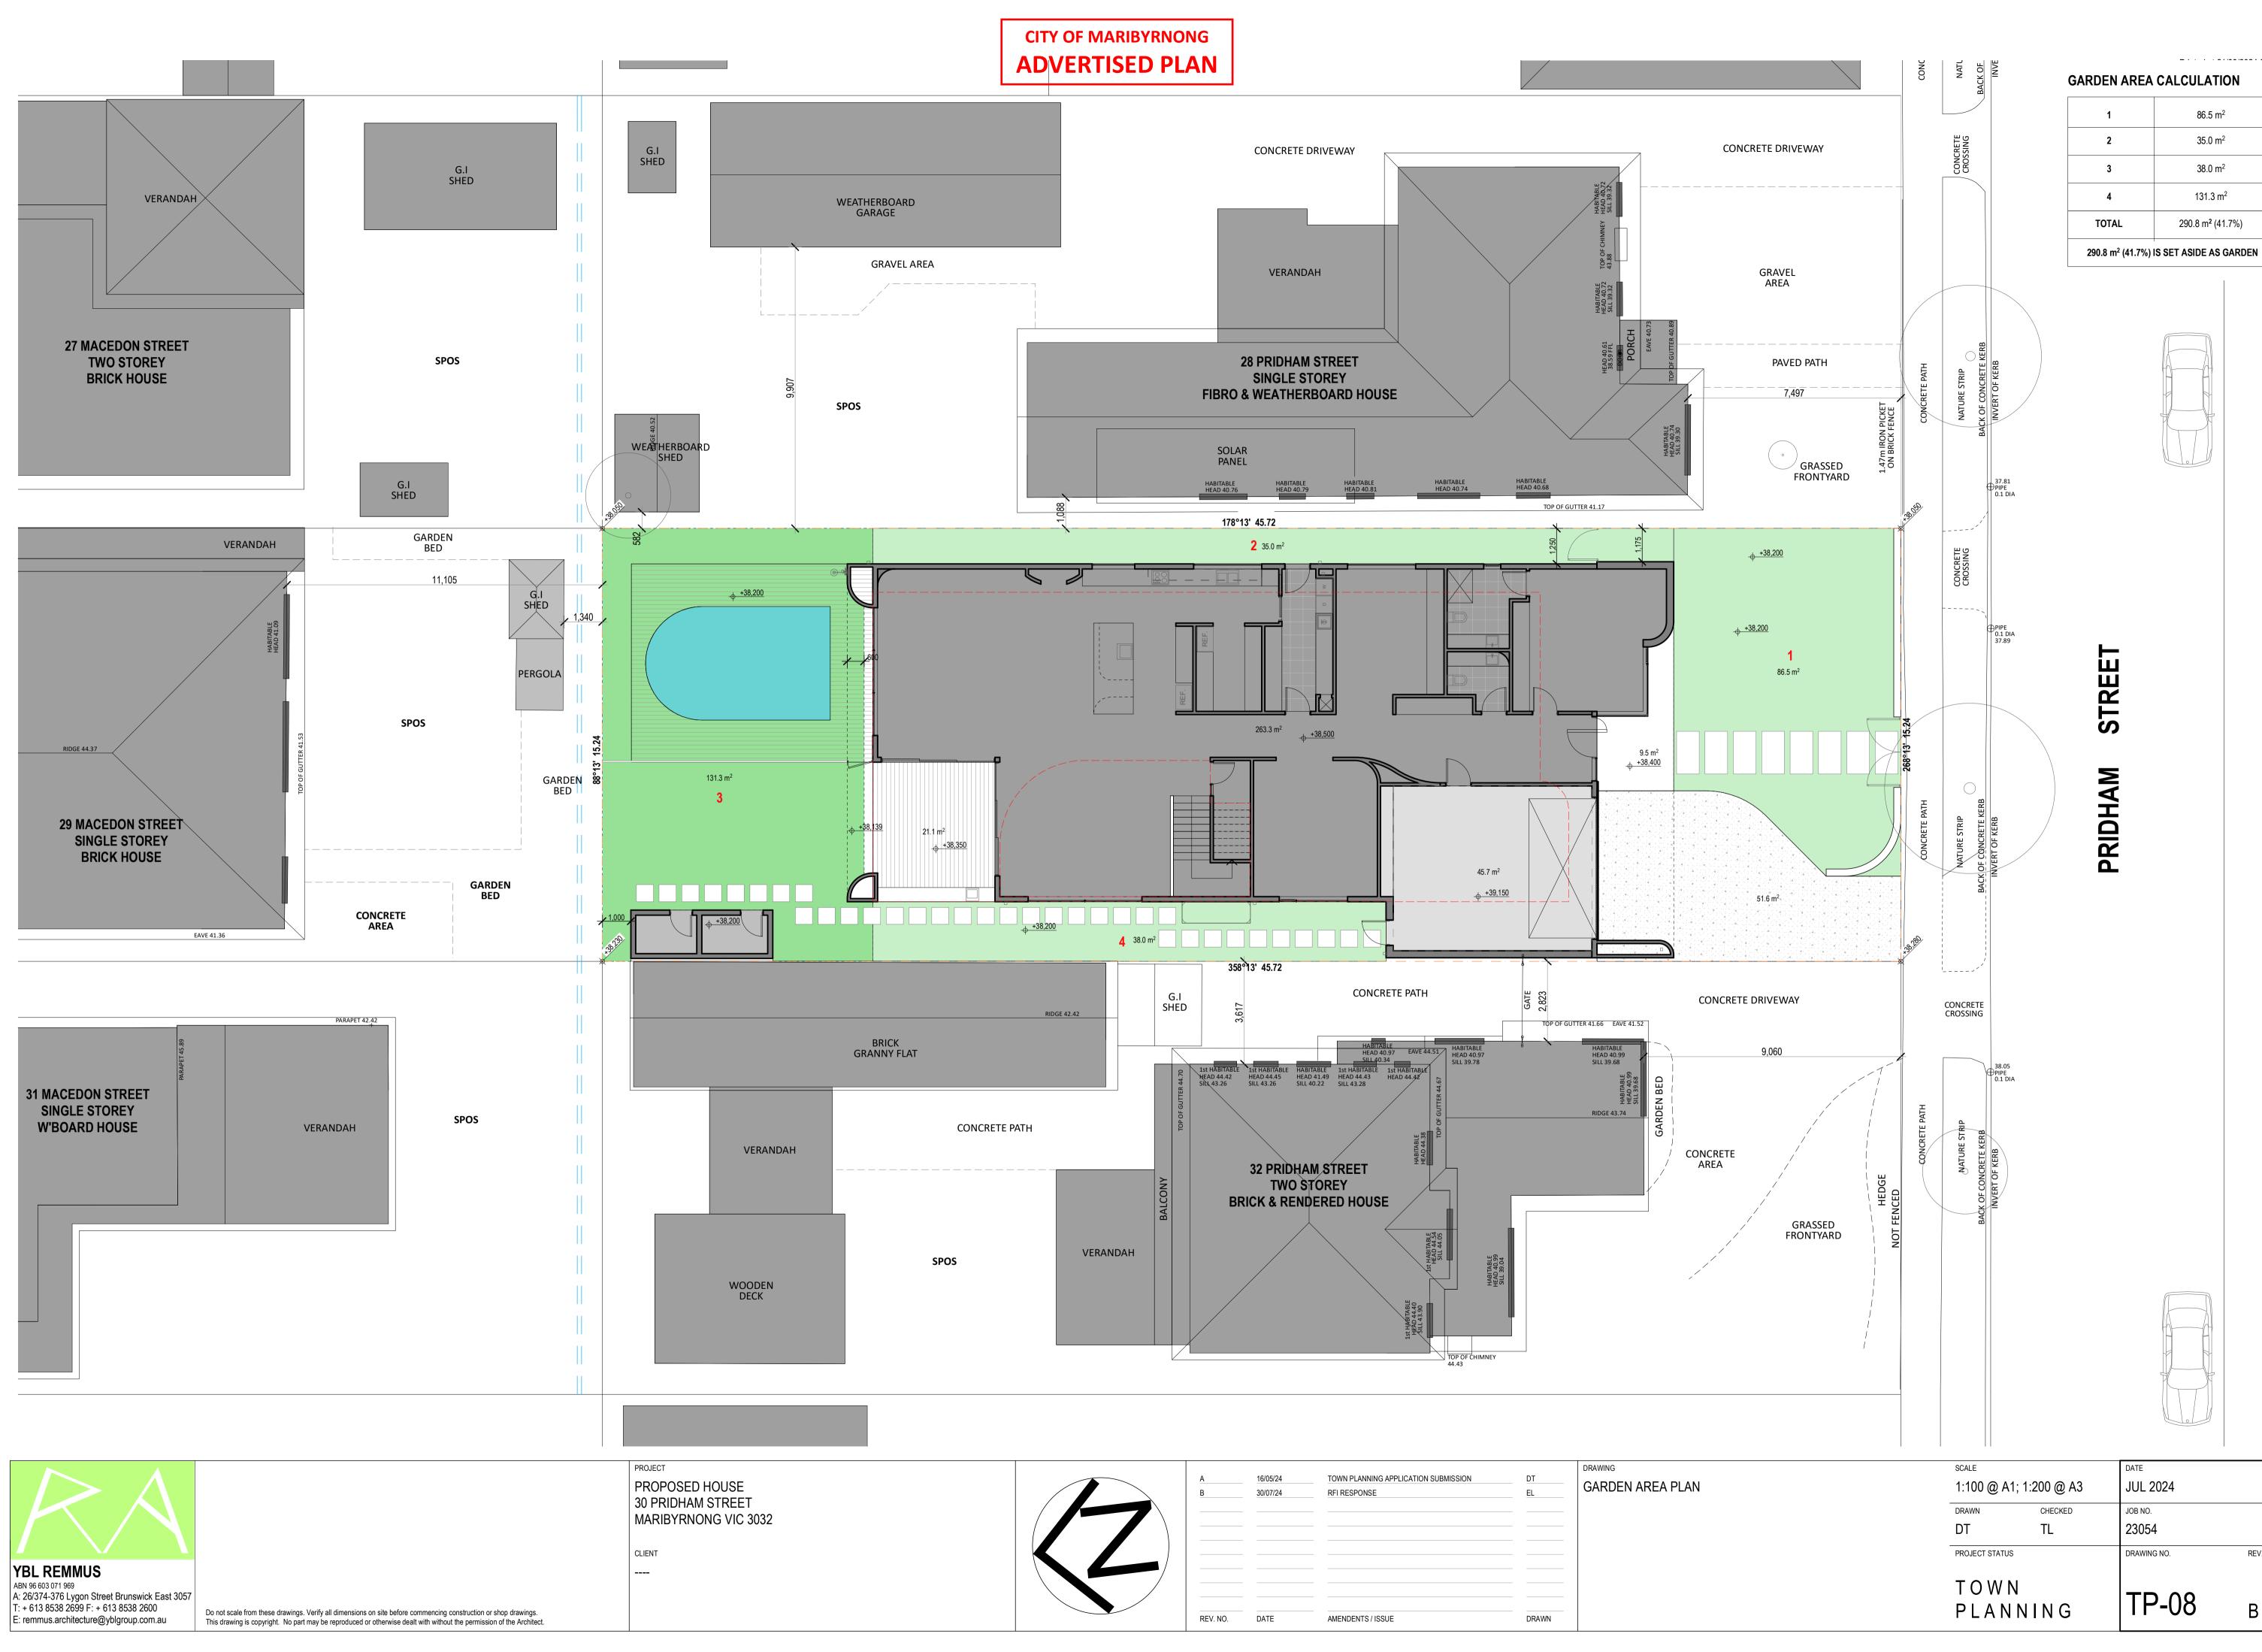

86.5 m²


35.0 m²

38.0 m²

131.3 m²

290.8 m² (41.7%)

JUL 2024 23054 DRAWING NO. REV. NO. **TP-08** В

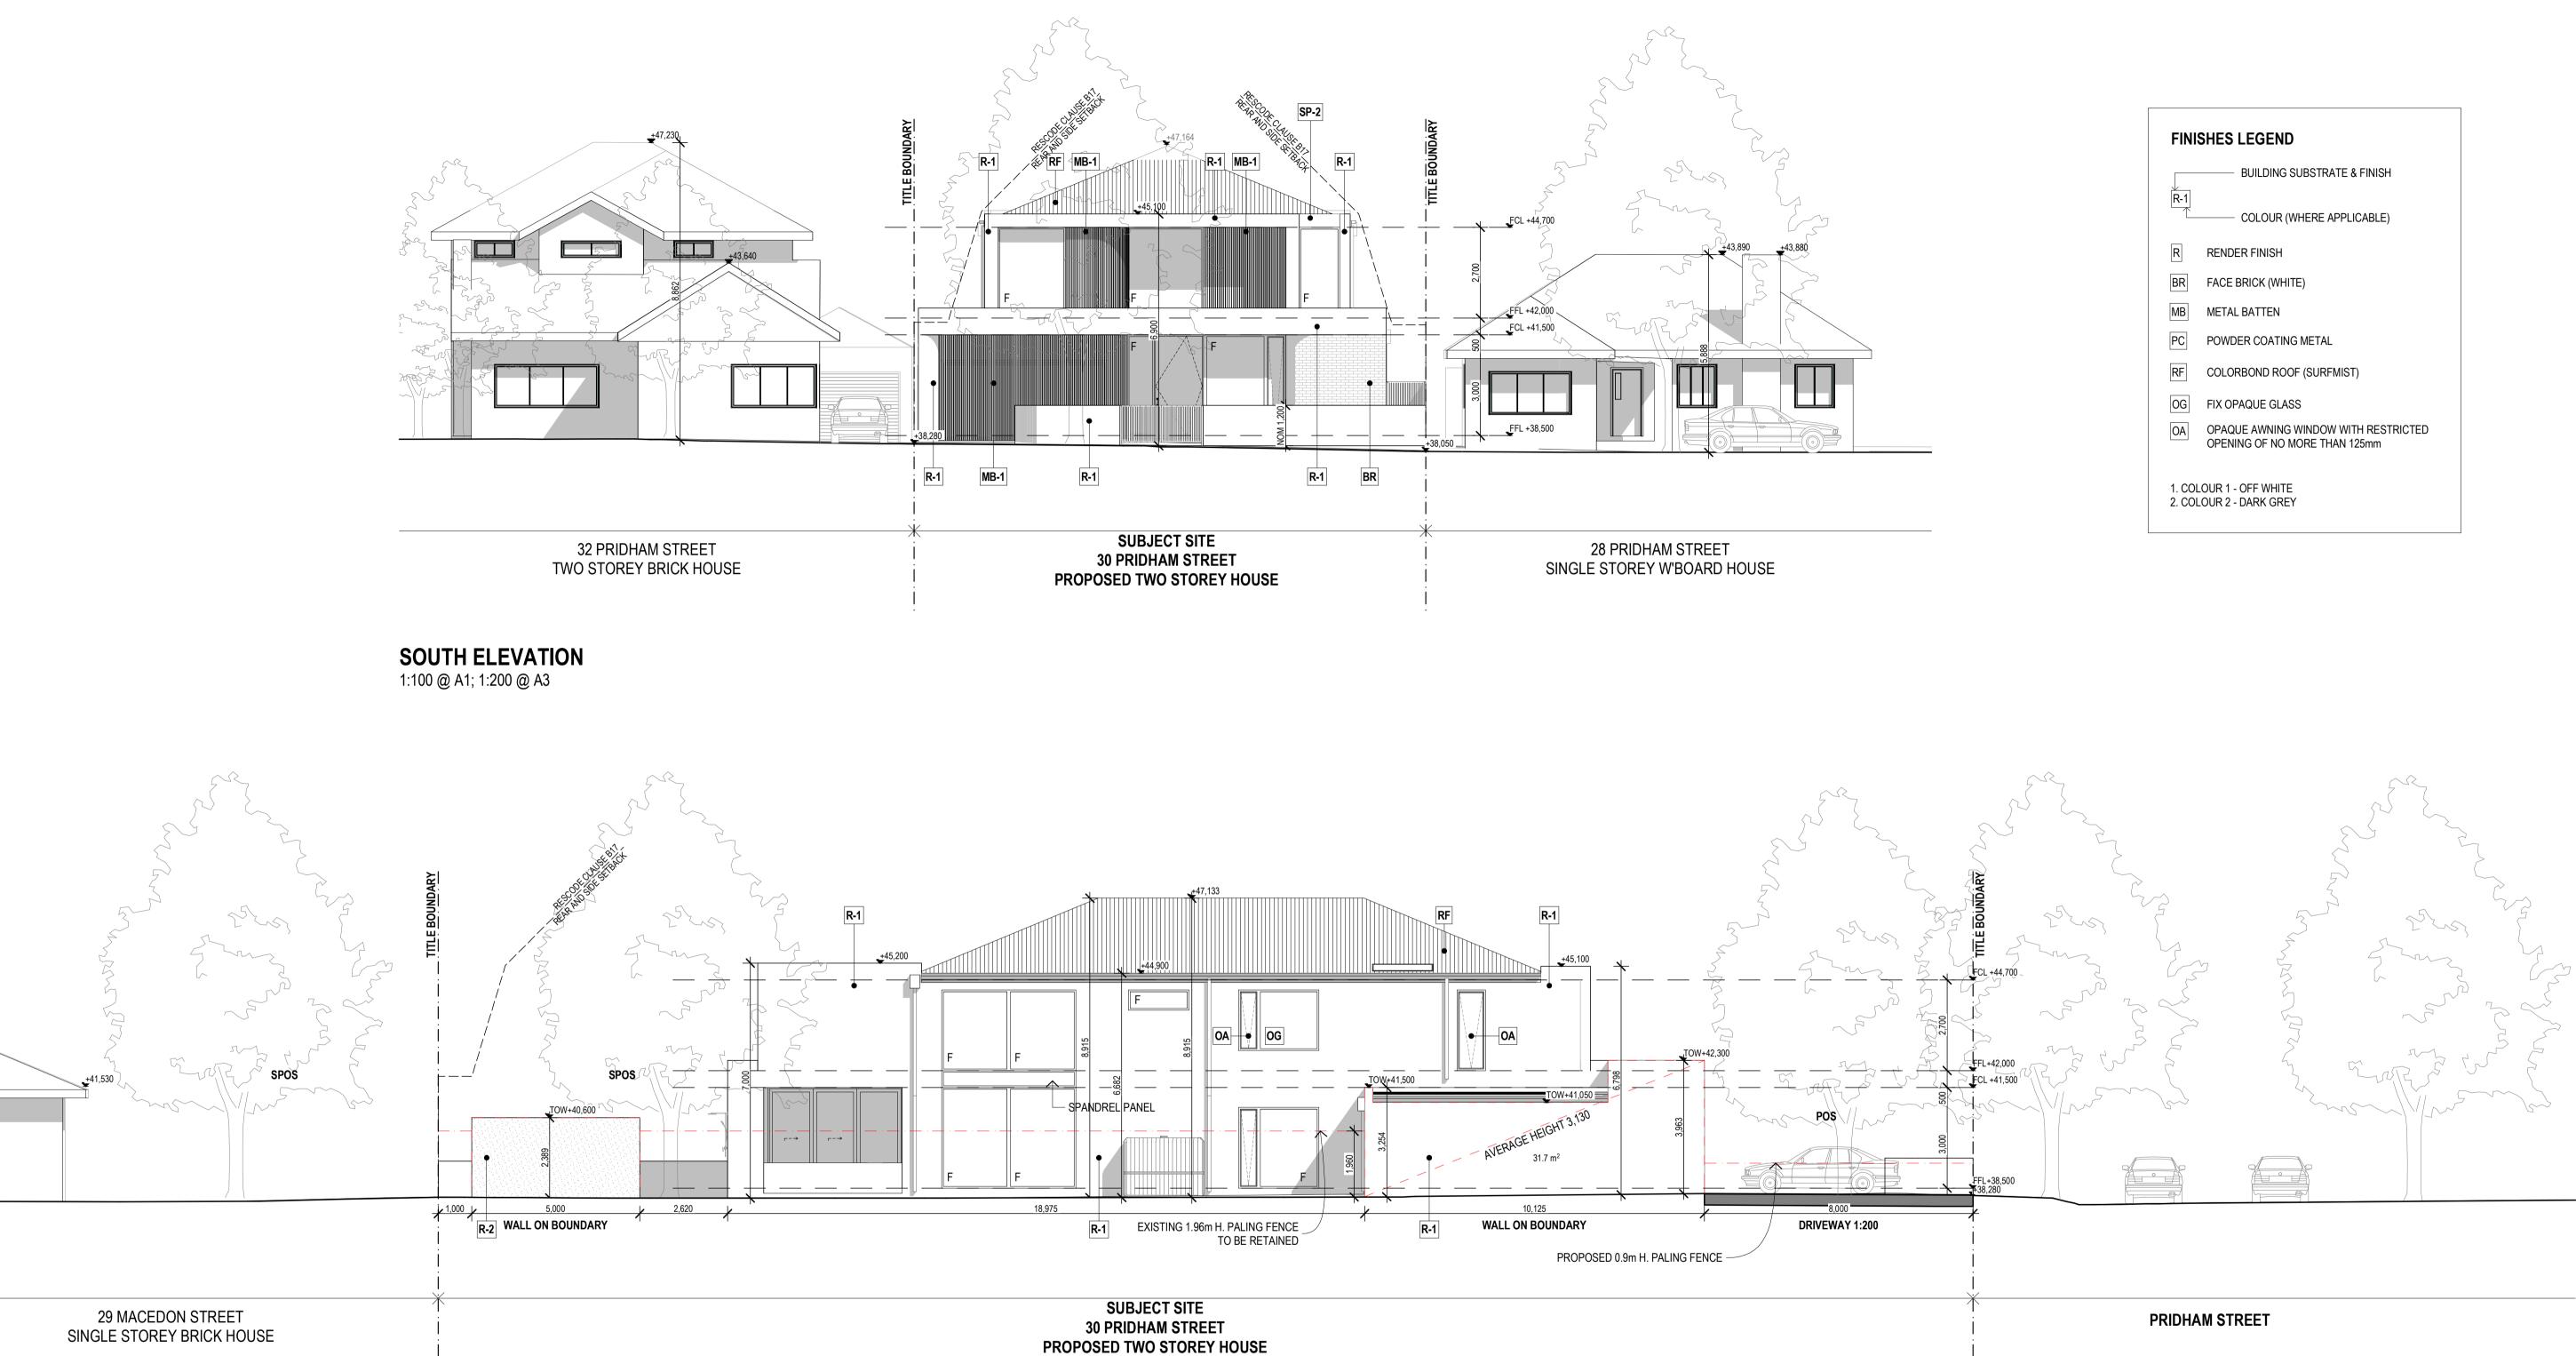


WEST ELEVATION 1:100 @ A1; 1:200 @ A3

PROJECT PROPOSED HOUSE 30 PRIDHAM STREET MARIBYRNONG VIC 3032 CLIENT YBL REMMUS ABN 96 603 071 969 A: 26/374-376 Lygon Street Brunswick East 3057 T: + 613 8538 2699 F: + 613 8538 2600 E: remmus.architecture@yblgroup.com.au Do not scale from these drawings. Verify all dimensions on site before commencing construction or shop drawings. This drawing is copyright. No part may be reproduced or otherwise dealt with without the permission of the Architect.


CITY OF MARIBYRNONG **ADVERTISED PLAN**

A 16/05/24 TOWN PLANNING APPLICATION SUBMISSION DT SOUTH AND WES	ST ELEVATIONS
B 30/07/24 RFI RESPONSE EL SOOTTAND WE	-
REV. NO. DATE AMENDENTS / ISSUE DRAWN	


CITY OF MARIBYRNONG RECEIVED 03/09/2024 URBAN PLANNING

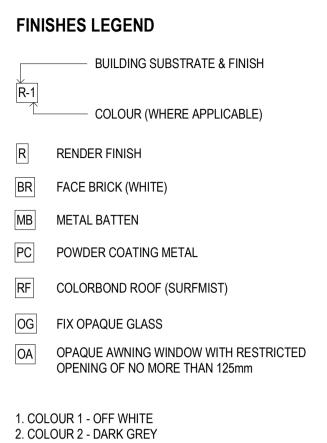


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	SCALE		DATE	

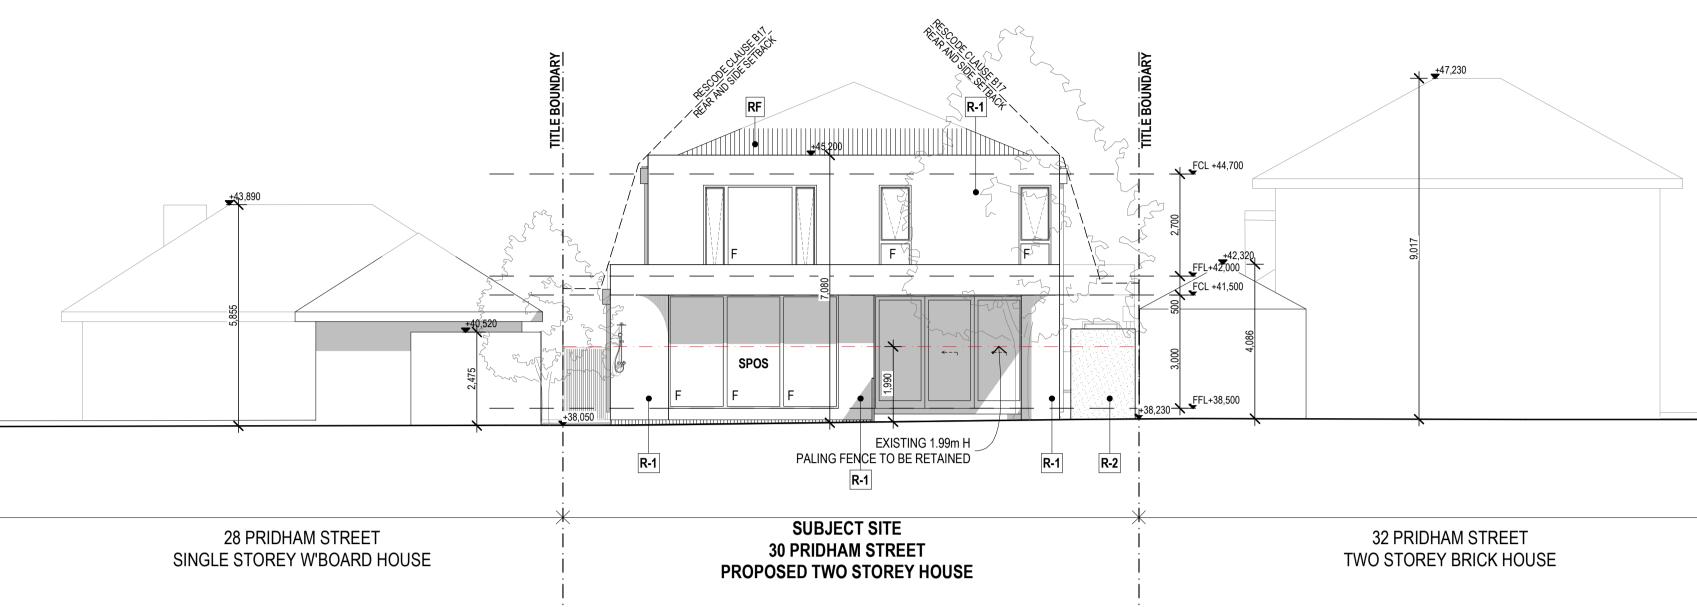

NORTH ELEVATION 1:100 @ A1; 1:200 @ A3

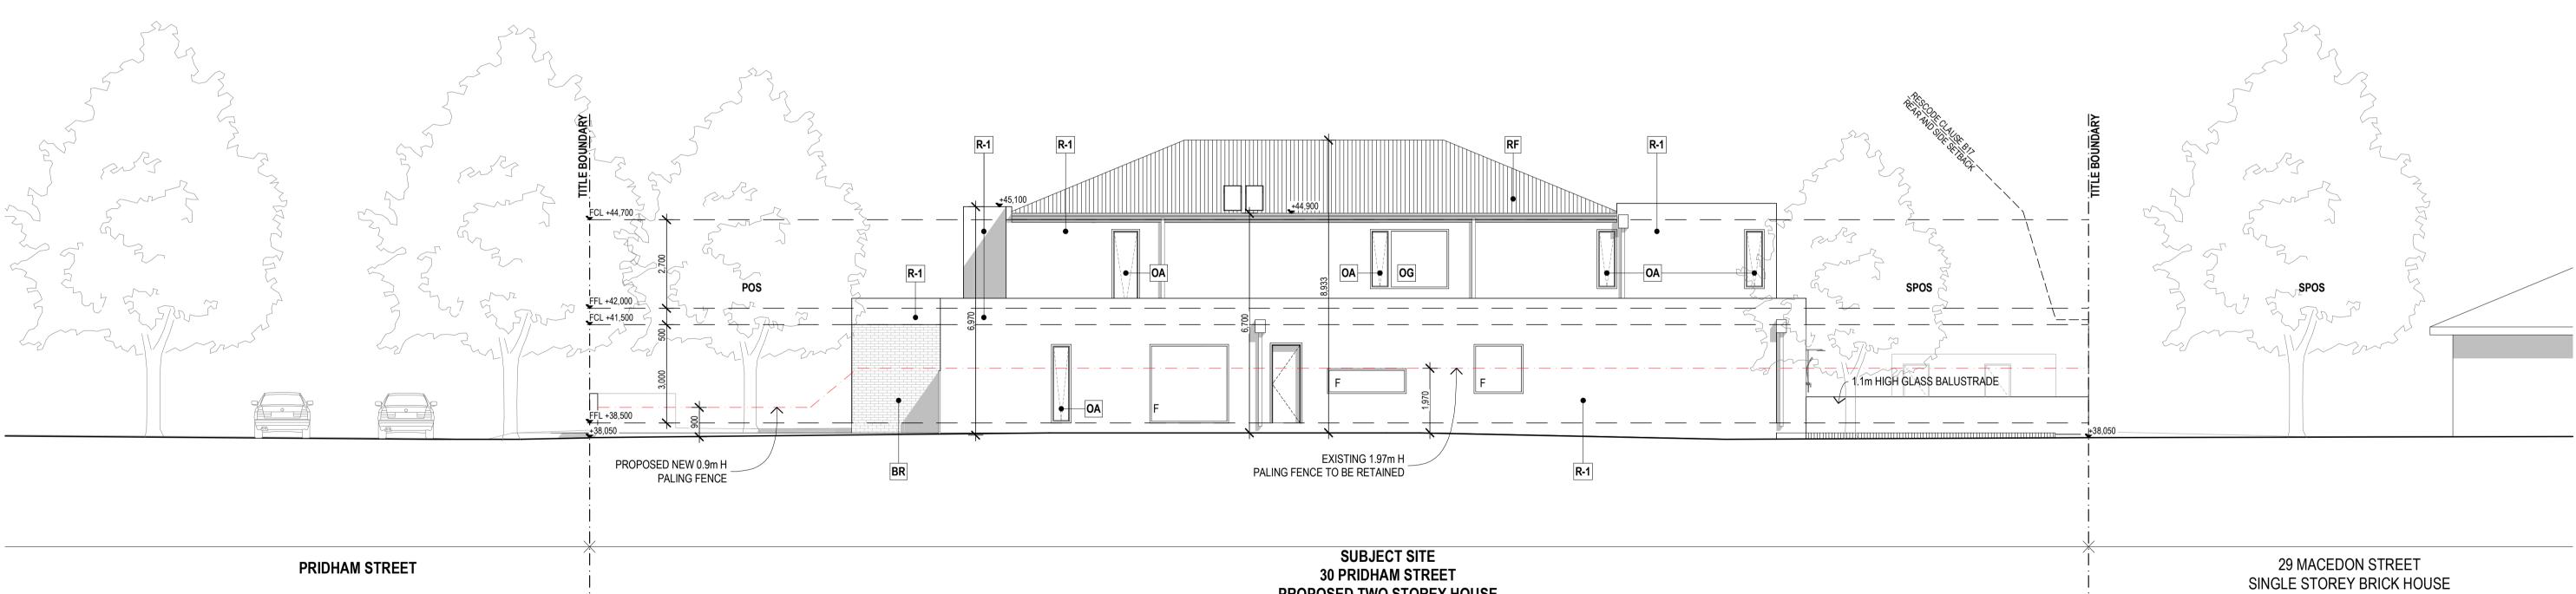

EAST ELEVATION 1:100 @ A1; 1:200 @ A3

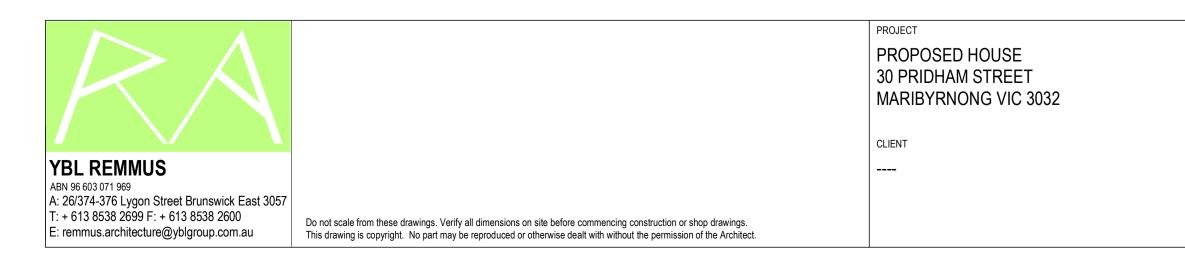


CITY OF MARIBYRNONG ADVERTISED PLAN

PROPOSED TWO STOREY HOUSE

REV. NO.	DATE	AMENDENTS / ISSUE	DRAWN	
В	30/07/24	RFI RESPONSE	EL	NORTH AND EAST ELEVATIONS
А	16/05/24	TOWN PLANNING APPLICATION SUBMISSION	DT	

SCALE		DATE	
1:100 @ A1; 1:	200 @ A3	JUL 2024	
DRAWN	CHECKED	JOB NO.	
DT	TL	23054	
PROJECT STATUS		DRAWING NO.	REV. NO.
T O W N P L A N N	ING	TP-10	В

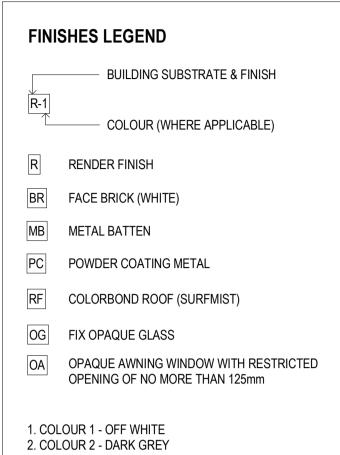







 YBL REMMUS

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PROJECT PROPOSED HOUSE 30 PRIDHAM STREET MARIBYRNONG VIC 3032

CLIENT

CITY OF MARIBYRNONG DVERTISED PLAN

RENDER FINISH COLOUR 1: OFF WHITE



FACE BRICK COLOUR: WHITE



A B	16/05/24 30/07/24	TOWN PLANNING APPLICATION SUBMISSION RFI RESPONSE	DT EL	DRAWING PERSPECTIVES & MATERIAL PALETTE 1	scale N/A		date JUL 2024	
					drawn DT	checked TL	јов NO. 23054	
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COLORBOND ROOF COLOUR: SURFMIST








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PROJECT PROPOSED HOUSE 30 PRIDHAM STREET MARIBYRNONG VIC 3032

CLIENT

CITY OF MARIBYRNONG

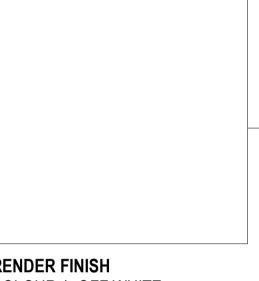

RENDER FINISH COLOUR 1: OFF WHITE



FACE BRICK COLOUR: WHITE

	10/05/04		DT	DRAWING
<u>A</u>	16/05/24	TOWN PLANNING APPLICATION SUBMISSION	DT	PERSPECTIVES & MATERIAL PAI
В	30/07/24	RFI RESPONSE	EL	
REV. NO.	DATE	AMENDENTS / ISSUE	DRAWN	



COLORBOND ROOF COLOUR: SURFMIST

	SCALE		DATE	
ALETTE 2	N/A		JUL 2024	
	DRAWN	CHECKED	JOB NO.	
	DT	TL	23054	
	PROJECT STATUS		DRAWING NO.	REV. NO.
	T O W N P L A N N	I N G	TP-15	В



Swimming Pool Terrace

Silver Travertine Tiles boast a high non-slip rating and pure stone composition. They are wellsuited for pool coping and have excellent weather resistance. This recommendation is versatile and can be customized to align with the owner's preferences while preserving these key attributes.

Design Ideas for the Northeastern Corner To address the proximity of neighbouring structures, we propose using large shrubs and strategic landscaping to create a natural screen along the northeastern corner of the property.

Additionally, we suggest planting a small to mediumsized deciduous tree in this area. This tree will balance sunlight penetration during winter and shade during summer, creating a comfortable and dynamic environment. Moreover, when viewed from the living room, the planting will serve as an aesthetically pleasing backdrop for the swimming pool area, enhancing the overall visual appeal and privacy of the property.

Design Idea for the Northwestern Corner The area in the northwestern corner of the property is set aside for a sauna and garden shed. To create a smooth transition between the timber outdoor dining area and the tiled deck around the pool, we plan to have an open lawn with drought-resistant grass. This will make a green connection and provide space for children to play freely in the backyard.

Strategic planting along the fence will feature a medium-sized evergreen tree, providing yearround privacy and a visually appealing focal point when viewed from the dining room or timber deck. This thoughtful landscaping will enhance the overall beauty and functionality of the backyard while offering a balanced space for relaxation and recreation.

LANDSCAPE CONCEPT

The landscape design for this residential property aims to create a cohesive, functional, and aesthetically pleasing outdoor environment that enhances the living experience. The design integrates safety, privacy, usability, and visual appeal through strategic planting, versatile materials, and thoughtful layout.

Key Elements:

Swimming Pool Terrace

Paved with Silver Travertine Tile that is high non-slip rating and durable, providing a safe and elegant poolside surface.

Privacy and Screening

Northeastern Corner: Large shrubs and a deciduous tree form a natural screen, ensuring privacy from neighbouring structures while balancing seasonal sunlight. This area also serves as a picturesque backdrop for the pool when viewed from the living room.

Side Fence Planting: A 300mm wide vertical planting strip with trellises for climbing plants, along with lower shrubs and groundcovers, softening the visual impact of the side fence.


Recreational and Functional Spaces

Northwestern Corner: An open lawn with droughtresistant grass provides a green connection between the timber outdoor dining area and the tiled pool deck and offers a space for children to play. An evergreen tree enhances privacy and visual interest.

Mini-Deck Addition: A seamless transition between the pool terrace and alfresco deck with a mini-deck improves flow and functionality for outdoor activities.

Paths and Paving

Permeable Pavers: Butt-joint concrete pavers for clothlines area and front pedestrian path, promoting water absorption and offering design flexibility.

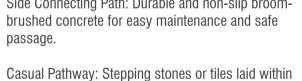

a gravel bed, ensuring easy access and minimal maintenance while connecting various garden areas.

Front and Driveway Landscaping

Front Gardens: Garden beds along the front fence, planted with trees, shrubs, and groundcovers, provide a pleasant view from the house. Tree canopies, taller than the fence height, soften the front facade and enhance street presence when viewed from the street.

Driveway: Exposed aggregate in a natural sand colour to improve texture and traction, blending seamlessly with the overall design.

Focal Points and Garden Features

Water Feature: A tiered, wall-mounted waterfall with linear spouts, creating a striking focal point visible from the dining room.

Sauna and Garden Shed Area: Integrated into the northwestern corner with strategic planting for privacy and a smooth transition between different outdoor areas.

This landscape concept blends functionality with beauty, offering a private, safe, and enjoyable outdoor space that complements the property's architecture and enhances the residents' quality of life.

PLANTING PALETTE

The selection of plants for this project will focus on a diverse range of exotic and native species well-suited to the local climate and soil conditions. Emphasis will be placed on plants that offer year-round interest, provide privacy and screening where needed, and contribute to the overall aesthetic of the landscape design. The planting palette will include:

- > Evergreen trees and shrubs for year-round colour and privacy
- > Deciduous trees for seasonal interest and filtered shade
- > Shrubs and flowering plants to attract pollinators and add visual interest
- > Groundcovers to prevent erosion and unify the landscape
- > Drought-tolerant grasses and plants to conserve water and minimise maintenance


Plants will be selected to be compatible with the desired design aesthetic, ensuring the final landscape is functional and meets the aesthetic purpose.




Lomandra longifolia 'Tanika'

Dianella revoluta 'Little Rev'

Pyrus calleryana 'Capital'

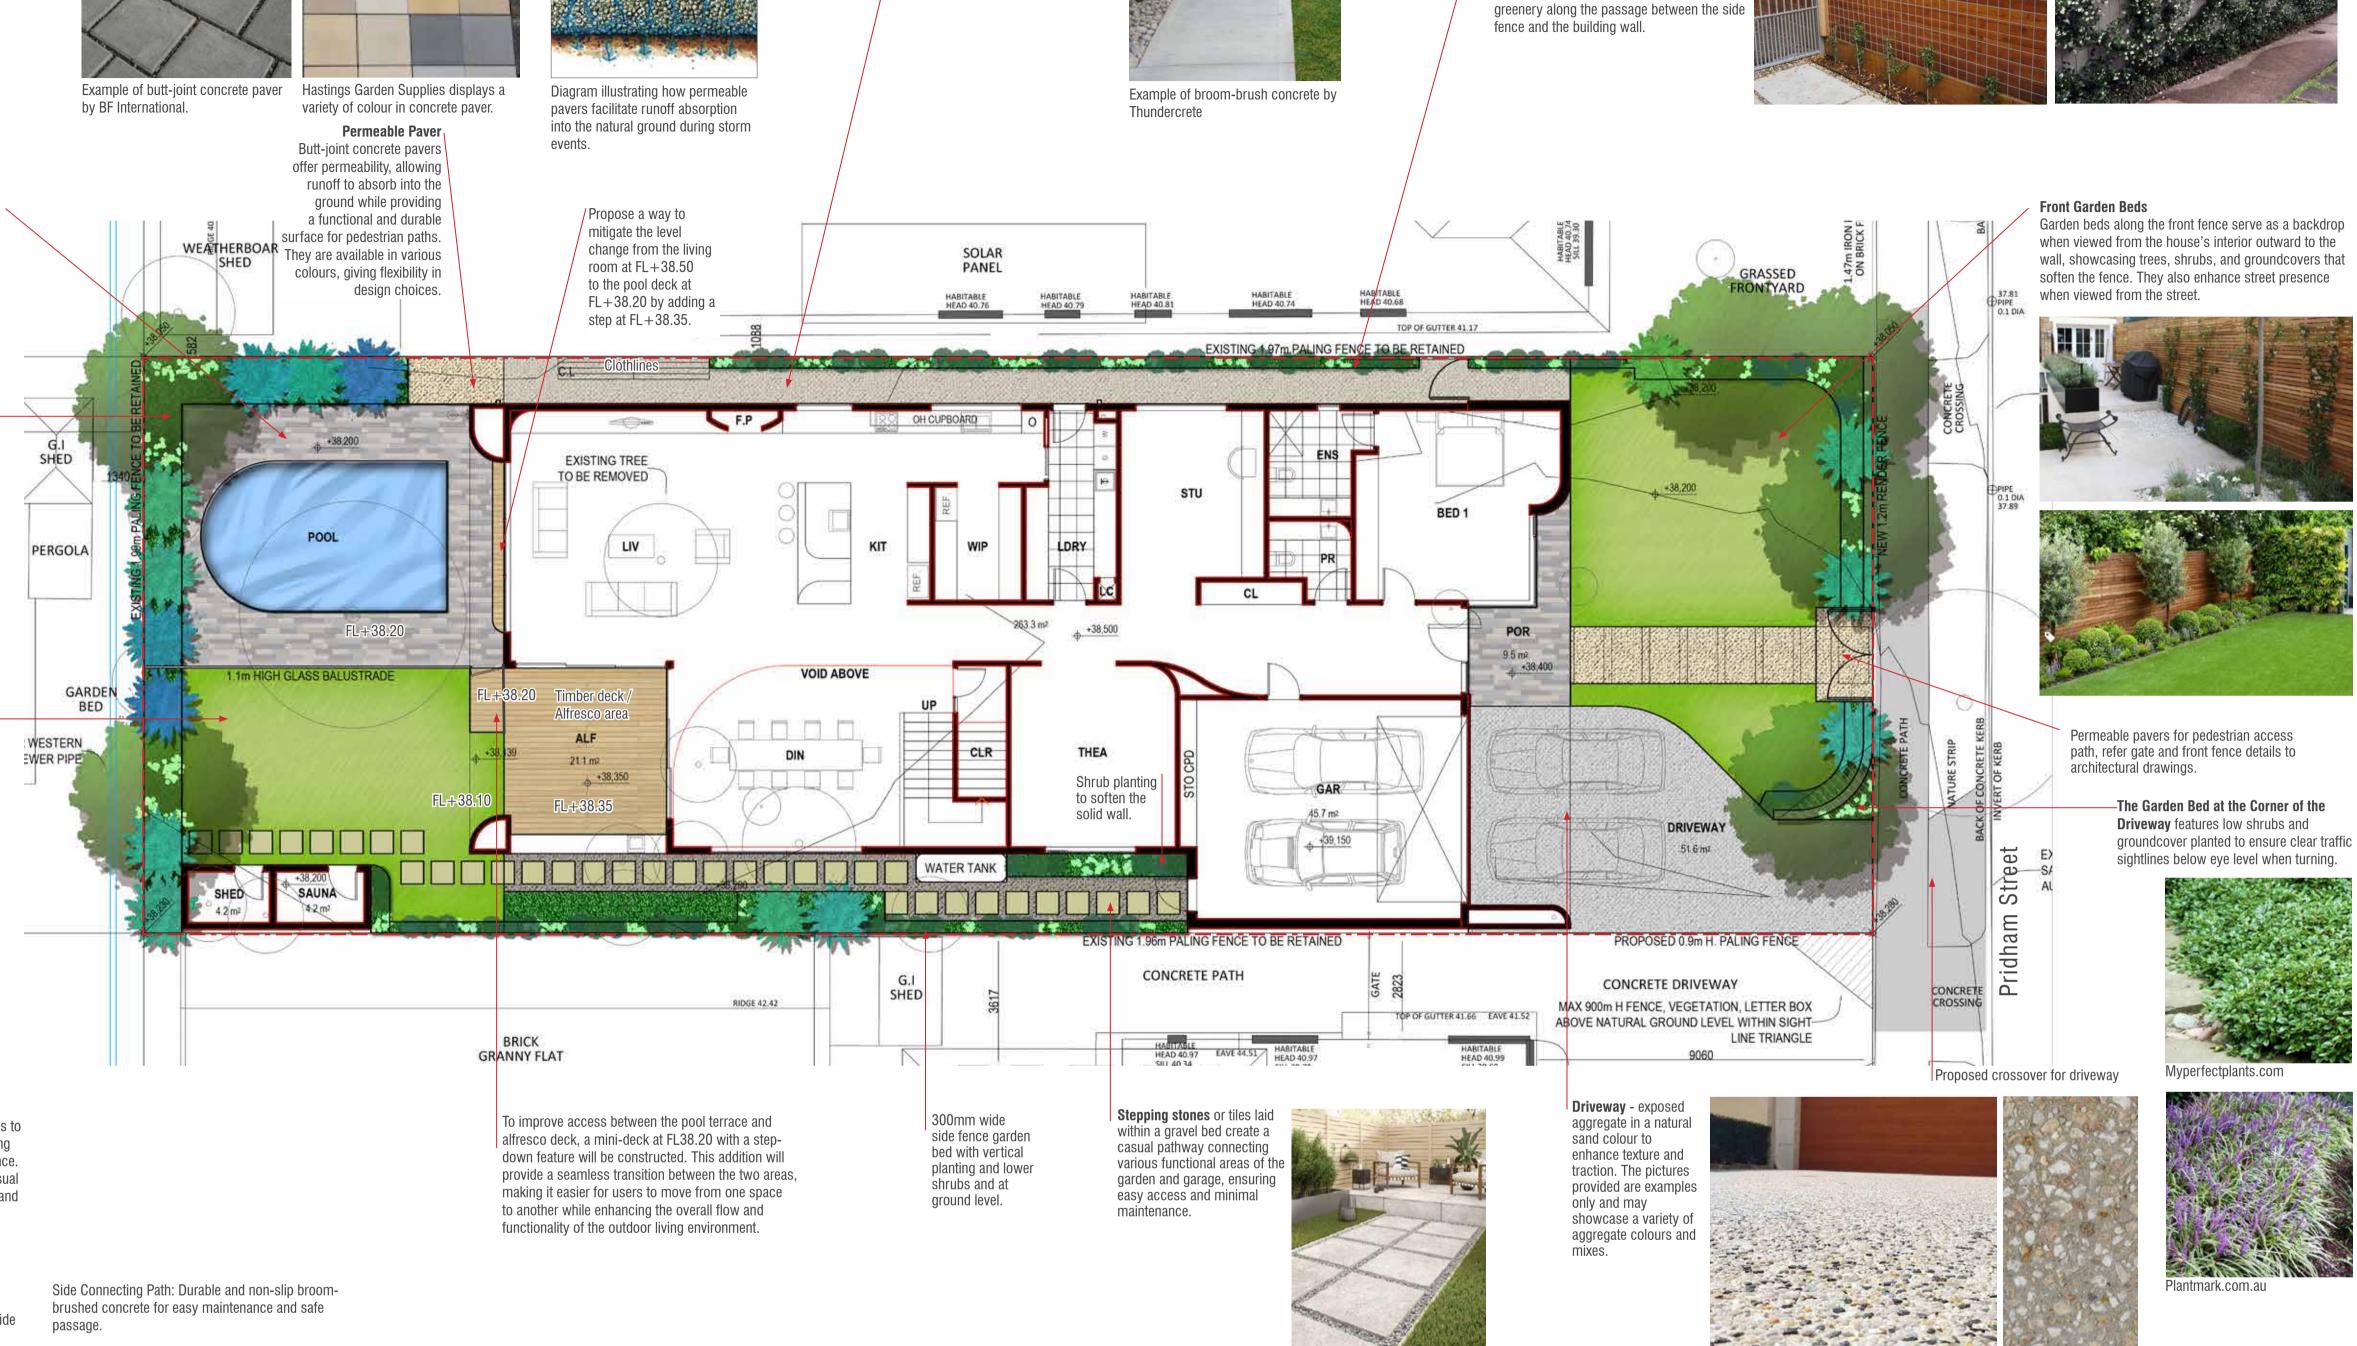

CITY OF MARIBYRNONG ADVERTISED PLAN

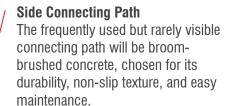



Side Fence Planting

Due to the narrow space between the building wall and the fence, a 300mm wide vertical planting strip is proposed. This design will incorporate trellises and supports for climbing plants, creating a visually softening effect on the fence and adding




Prunus 'Kojo-no-mai' from Flaming Trees

Magnolia grandiflora 'TMGH' - Alta



LEGEND

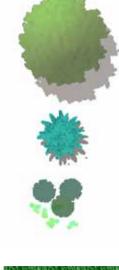











Proposed canopy tree

Mixed native and exotic trees for seasonal colours and filtered sunlight, softening the modern facade.

Large Shrubs

A mix of shrub varieties for year-round visual interest and privacy screening, softening the appearance of the fence line.

Small Shrubs and groundcovers

Shrubs and groundcovers add texture and colour for enhanced visual interest.

Garden bed

300mm depth topsoil, bordered by timber or steel edging.

Lawn Drought-tolerant, non-invasive species,

seeded or turfed on 50mm topsoil.

Permeable Paver

Enhances runoff absorption, featuring a non-slip texture and attractive appearance and colour.

Feature Tiles

For areas surrounding the swimming pool and front porch, a non-slip surface that is high quality and has a rich appearance.

Timber Deck

Over the outdoor alfresco terrace provides a porous surface for water drainage and a soft, natural texture to enhance the outdoor living area.

Driveway

Exposed aggregate concrete for added texture and improved traction.

Fencing


Refer to the architectural plan

Site Boundary - extent of works

Note: The images in this presentation are sourced from the Internet and used solely as examples for discussion purposes. There is no intention of duplicating designs.

30 PRIDHAM STREET MARIBYRNONG, VIC 3032

LA01 - LANDSCAPE CONCEPT PLAN

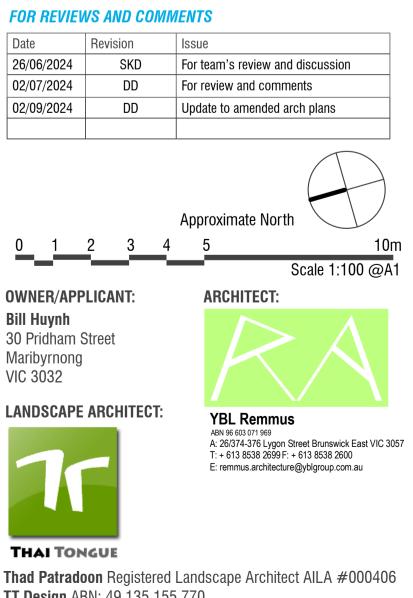






Aurraya paniculata



THAI TONGUE

TT Design ABN: 49 135 155 770 Address: U211/229 Toorak Road, South Yarra, VIC 3141 Phone: 0408 199 815 Email: design@thaitongue.com.au

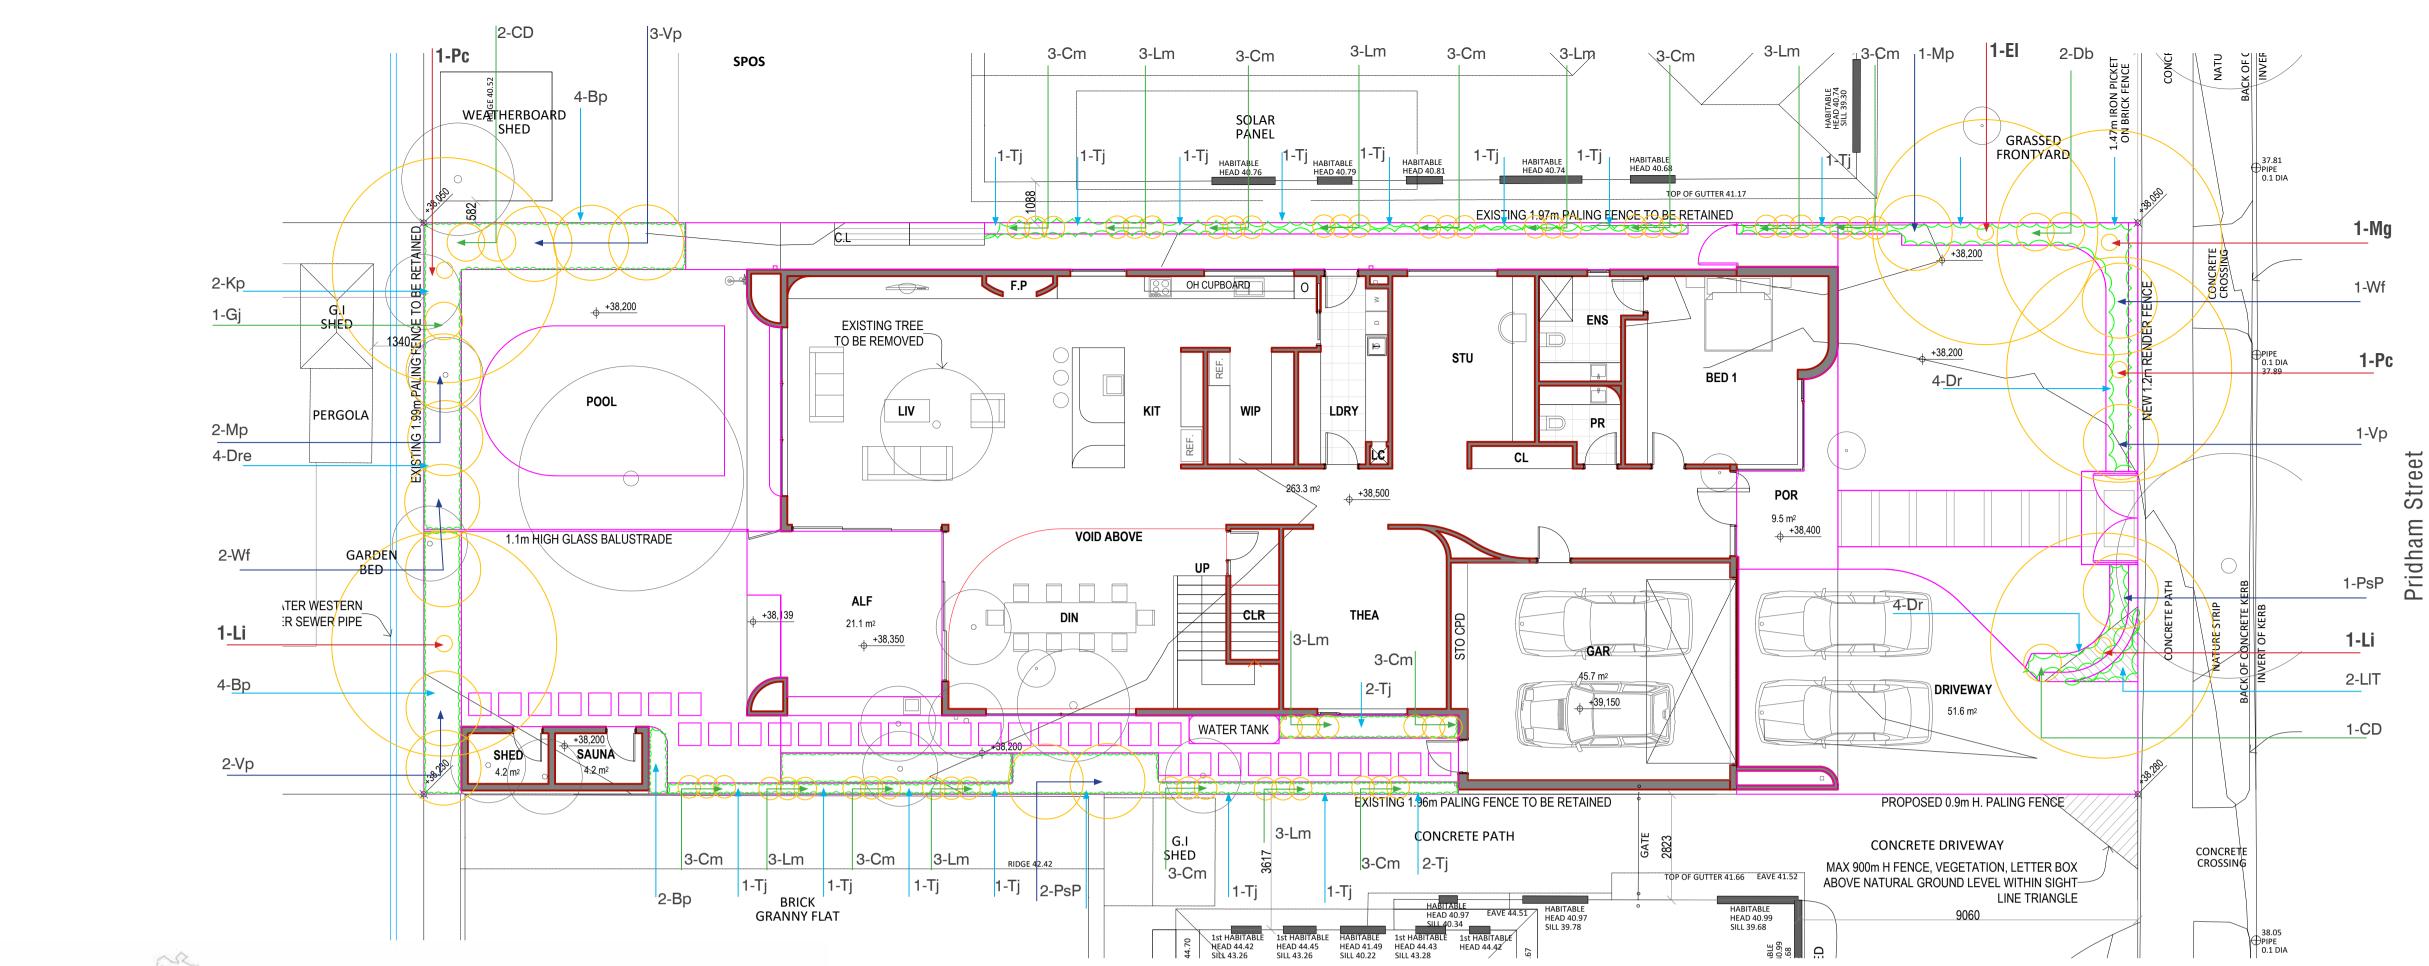



PROPOSED PLANTING SCHEDULE

Symbol	Botanic name	Common name	Installation size	Mature size (HxW)	Quantity
Upright Tr	rees (min 1.5 m in height at installat	ion)			
El	Eucalyptus leucoxylon 'Euky Dwarf'	Dwarf Yellow Gum	450mm pot	4-10 X 3-4 m	1
Li	<i>Lagerstroemia indica x L. fauriei</i> 'Biloxi' Indian Summer®	Crepe Mrytle	450mm pot	7 X 5 m	2
Mg	Magnolia grandiflora 'TMGH' - Alta	Alta Magnolia	450mm pot	9 X 4 m	1
Pc	Pyrus calleryana 'Capital'	Capital calleryana Pear	450mm pot	11 X 3 m	2
Shrubs ar	nd Ground Covers	·			
Вр	Bossiaea prostrata	Creeping Bossiaea	140 mm pot	Spreading	10
CD	Correa 'Dusky Bells'	Dwarf Correa	140 mm pot	0.75 x 0.75 m	3
Cm	Clivea miniata	Kaffir Lily	140 mm pot	0.6 x 0.6 m	30
Dr	Dianella revoluta 'Little Rev'	Flax Lily	140 mm pot	0.75 x 0.75 m	8
Dre	Dichondra repens	Kidney Plan	140 mm pot	Spreading	4
Db	Dietes bicolor	Spanish Iris	140 mm pot	1 x 1 m	11
Gj	Gardenia jasminoides	Gardenia	200 mm pot	1 x 0.75 m	1
Кр	Kennedia prostrata	Running Postman	140 mm pot	Spreading	2
LIT	Lomandra longifolia 'Tanika'	Spiny-head Mat Lily	140 mm pot	0.7 x 0.7 m	2
Lm	Liriope muscari	Turf Lily	140 mm pot	0.5 x 0.5 m	24
Мр	Murraya paniculata	Murraya	200 mm pot	1.5 x 1.5 m	3
Psp	Phomium tenax	Red Flax	200 mm pot	1.2 x 1.2 m	3
Vp	Viburnum plicatum 'Newzam' - Newport	Newport Viburnum	200 mm pot	1.2 X 1.5 m	6
Wf	Westringia fruticosa	Native Rosemary	200 mm pot	1.5 x 1.5 m	3
Tj	Trachelospermum jasminoides	Star Jasmine	250 mm pot	Climbing / spreading	15

Notes:

1) *Height x width average at maturity estimated for this location or maintained by trimming.

Garden Beds Cultivate existing soil to 300mm. Re-use site topsoil if suitable or imported garden mix topsoil to provide minimum 100mm of topsoil to garden beds. Spread 75mm layer of 10mm pine bark mulch.

Fences Drainage

Services

Existing soil should be improved by the addition of organic matter and light cultivation only to break up any composition. No cultivation within driplines of existing retained trees on site or adjacent areas. Areas of possible contamination with paint, oil or any other materials used on site are to be removed and replaced with topsoil from a sustainable source and approved for use on site. Areas requiring topsoil to ensure levels or for plant growth are to be spread with approved soil previously stockpiled on site or from quality controlled and sustainable source.

maintained at 75mm.

LANDSCAPE NOTES

Existing Vegetation

Existing trees and shrubs indicated for retention are to be protected in accordance with Australian Standards. Refer to arborist's report and/or council conditions for tree protection and management. Trees should be protected with physical barriers to prevent access within nominated tree protection zones which are to be mulched and irrigated during construction. No trees to be removed without clarification from owner or local council. All tree protection to be in accordance with relevant Australian Standards.

Irrigation (Optional)

Low water use drip system with programmable timers connected to rainwater storage tanks or water mains. Irrigation must be used in compliance with current water restrictions.

Refer to architectural plans.

Refer to architectural or engineering plans for stormwater and drainage pit locations. All paved areas in rear gardens are to have a grade of 2.5% minimum, away from buildings, All grades, levels and drainage to comply with relevant building codes and council planning requirements.

Contractors are to determine the location of all underground and overhead services prior to construction. Any services, pits, etc. illustrated on this plan are indicative only and are to be checked with architectural and engineering plans.

Building Structures

The use of this plan and planting of trees, shrubs, etc as specified may require the provision of root control barriers or specifically engineered foundations or similar method of controlling root growth to avoid intrusion into the adjacent areas or building foundations. A qualified consultant should advise on foundation design and/or barriers (physical or chemical) as appropriate.


PREPARATION AND MAINTENANCE

All weeds to be removed from site by physical removal or spraying with glyphosate-based herbicide.

Irrigation is to be in accordance with current water restrictions and weather conditions generally 10 minutes every second day during establishment period (6 months) and during dry summer periods if required, programmable irrigation systems are to be low water use drippers and sprays as appropriated and designed by irrigation supplier or consultant.

Weeding and trimming every 14-21 days. Plant replacement as required during establishment period of 6 months or longer as required by permit conditions. All plants to be pruned/shaped to appropriate size on an ongoing basis. Mulch levels to be



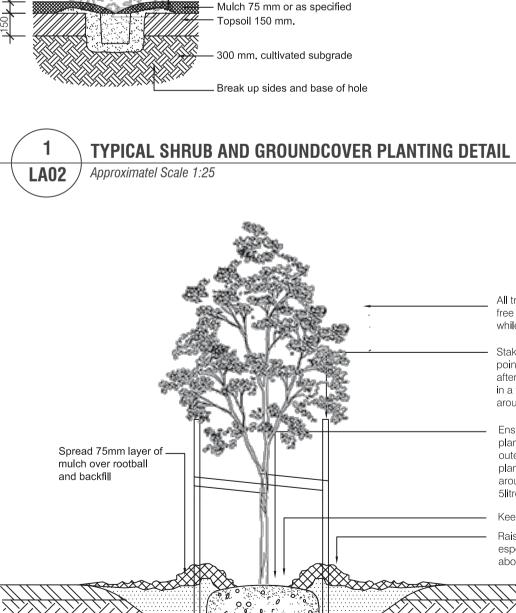

3. Place plant in centre of hole, backfill with approved topsoil, firming progressively.

5. Stake larger shrubs where necessary, using 50 x 50 x 1200 mm. hardwood stakes.

maintenance and establishment

Extend stakes into undisturbed soil —

90mmØ agg pipe connected to ---stormwater drainage

Shrub Planting Notes:


4. Water well into saucer around crown of plant.

TYPICAL TREE PLANTING DETAIL 2 **LA02** / Approximatel Scale 1:25

1. Dig hole twice as deep as rootball and allow at least 200 mm. around sides for backfilling with topsoil. 2. Apply fertiliser in base of hole, cover with topsoil (type & rate as per spec). Avoid root contact.

- Provide mounded topsoil berm to hold water during

LEGEND

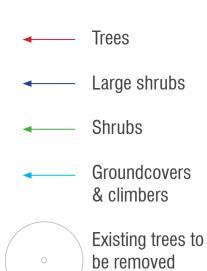


30 PRIDHAM STREET MARIBYRNONG, VIC 3032

LA02 - PLANTING PLAN

FOR REVIEWS AND COMMENTS

Date	Revision	Issue
26/06/2024	SKD	For team's review and discussion
02/07/2024	DD	For review and comments
02/09/2024	DD	Updated to amended arch plans

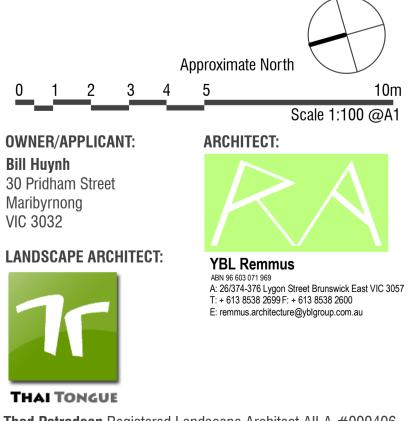

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